


LEGEND	
	AREA SUPPLIED BY ELECTRICAL DISTRIBUTION BOARD
	EXISTING ELECTRICAL DISTRIBUTION BOARD
	EXISTING ELECTRICAL DISTRIBUTION BOARD POWERED BY UPS
	EXISTING ELECTRICAL DISTRIBUTION BOARD POWERED BY GENERATOR
	APPLIANCE' S ELECTRICAL PANEL
	NEW ELECTRICAL DISTRIBUTION BOARD POWERED BY GENERATOR
	NEW ELECTRICAL DISTRIBUTION BOARD POWERED BY UPS
	2U PROFILE R-G WHITE DIL840047 6x21-39W DOWN+PC O SLS DIL811471 OS4039W/830-230V SLS L=540cm
	2U PROFILE R-G WHITE DIL840047 4x21-39W DOWN+PC O SLS DIL811471 OS4039W/830-230V SLS L=360cm
	2U PROFILE R-H WHITE DIL840047 4x21-39W DOWN+PC H SLS DIL811470 OS4039W/830-230V SLS L=360cm
	2U PROFILE R-H WHITE DIL840047 2x28-54W DOWN+PC H SLS DIL81670 OS4054W/830-230V SLS L=240cm
	2U PROFILE R-H WHITE DIL840047 2x28-54W DOWN+PC H SLS DIL81670 OS4054W/830-230V SLS L=480cm
	2U PROFILE R-H WHITE DIL840047 2x21-39W DOWN+PC H SLS DIL811470 OS4039W/830-230V SLS L=180cm
	2U PROFILE S-ANO DIL810047 4x21W-39W DOWN 1x DIL811400 05-T16-2x39W-EVG 230V L=360cm
	2U PROFILE C-ANO DIL810012 1x35W-49W DOWN 1x DIL810800 05-T16-49W-EVG 230V L=150cm
	2U PROFILE C-ANO DIL810012 1x28W-54W DOWN 1x DIL810600 05-T16-54W-EVG 230V L=120cm
	2U PROFILE S-ANO DIL810012 1x35W-49W DOWN 1x DIL810800 05-T16-49W-EVG 230V L=150cm
	2U PROFILE R-H WHITE DIL840047 1x35-49W DOWN+PC H DIL810860 05-T16-49W-EVG 230V L=150cm
	PUJ ALTO 3D FLAT WHITE OC108068BCB LED 18W - 2700K OC618509527 DRIVER 47V-500mA OC621850
	PUJ SOSPESO OC1215EBB LED 26W-OC6269527D-2700K LED 18W-OC618509527-2700K DIMMER 26W-OC622571 DIMMER 18W-OC621852
	S82 TRIMLESS WHITE MOL8-33807 GU5.3-GR-C51- 1x max50W- 12V M/512V/60W4
	SOFFITO SINGOLO OC6P1200C SENTO E OC6K0075C 2xLED-13W-2700K-OC618509527
	FLEXIBLE LED COLD WARM WHITE NOS01100511W05A NOEL 24W-12V-DC-NO899520000 ALU PROFILE NOS011146702
	COSTANZA LPL1D13GSH0020 WHITE SHADE, SENSOR DIMMER E27-QT32- 3x max100W- 230V
	COSTANZA LPL1D13NSDA20020 WHITE SHADE, LPL1D1300ONT002 E27-QT32-1xmax 150W-230V
	CAVE R SINGLE W.W.H. DIL844027 PLASTERKIT DIL844090 P.LED 1x1W- 230V
	GEENA DIL182087 SMD LED 1x0.75W- 12V- 50Hz DC CONVERTERS DIL40024
	1U PROFILE WHITE DIL952047 LED 3000K 19.2W/M-24V DIL952200 SPRING MOUNTING DIL952905 STRAIGHT CONNECTOR DIL952080 L=400cm
	VISIBLE II HY WHITE MOL305-1440w GU10-1x P.LED5,2W/830- 230V
	THOR TWIN HIPAR111 WHITE Q48,5-HI PAR111-2x35W-230V
	ECLIPS HIT WHITE DIL428188 012-HIT-70W SIENH070WEL
	THOR WHITE-W.W.H. DIL318327 P.LED-3000K
	ECLIPS PLUS QR111 DIL428187 053-GR-LP111IRC-1xmax100W-12V M/S 12V/100WES
	GEENO MINI OBO AND DIL369182 TUBE DIL366308 SMD LED 1x0.75W-12V-50Hz-BLUE CONVERTED DIL40024
	4U PROFILE DIL09247 G5 2x49W
	NEW PRESENCE DETECTOR
	NEW EXIT EMERGENCY LIGHTS
	NEW EXIT EMERGENCY LIGHTS
	RELOCATED RECESSED LIGHTING FIXTURE WITH FLUORESCENT LAMPS 2x58W
	RELOCATED RECESSED LIGHTING FIXTURE WITH FLUORESCENT LAMPS 3x18W
	RELOCATED RECESSED LIGHTING FIXTURE SPOT
	RELOCATED LIGHTING FIXTURE SPOT
	RELOCATED EXIT EMERGENCY LIGHTS
	RELOCATED EXIT EMERGENCY LIGHTS
	EXISTING RECESSED LIGHTING FIXTURE WITH FLUORESCENT LAMPS 3x18W
	EXISTING RECESSED LIGHTING FIXTURE WITH FLUORESCENT LAMPS 2x58W
	EXISTING RECESSED LIGHTING FIXTURE SPOT
	EXISTING LIGHTING FIXTURE SPOT
	EXISTING LIGHTING FIXTURE SPOT
	EXISTING PRESENCE DETECTOR
	NEW ONE WAY SWITCH
	NEW A/R WAY SWITCH
	NEW DOUBLE WAY SWITCH
	EXISTING ONE WAY SWITCH
	EXISTING A/R WAY SWITCH
	EXISTING DOUBLE WAY SWITCH
	CONTROL "x" OF EXISTING LINE (NORMAL POWER)
	CONTROL "x" OF EXISTING LINE (EMERGENCY)
	CONTROL "y" SUPPLIED BY LINE "y" (NORMAL POWER) OF DISTRIBUTION BOARD
	CONTROL "y" SUPPLIED BY LINE "y" (EMERGENCY) OF DISTRIBUTION BOARD
	LUMINAIRE SUPPLIED BY LINE "y" (NORMAL POWER) VIA LATCHING RELAY AND CONTROLLED BY BUTTON "x0"
	LUMINAIRE SUPPLIED BY LINE "y" (EMERGENCY) VIA LATCHING RELAY AND CONTROLLED BY BUTTON "x0"

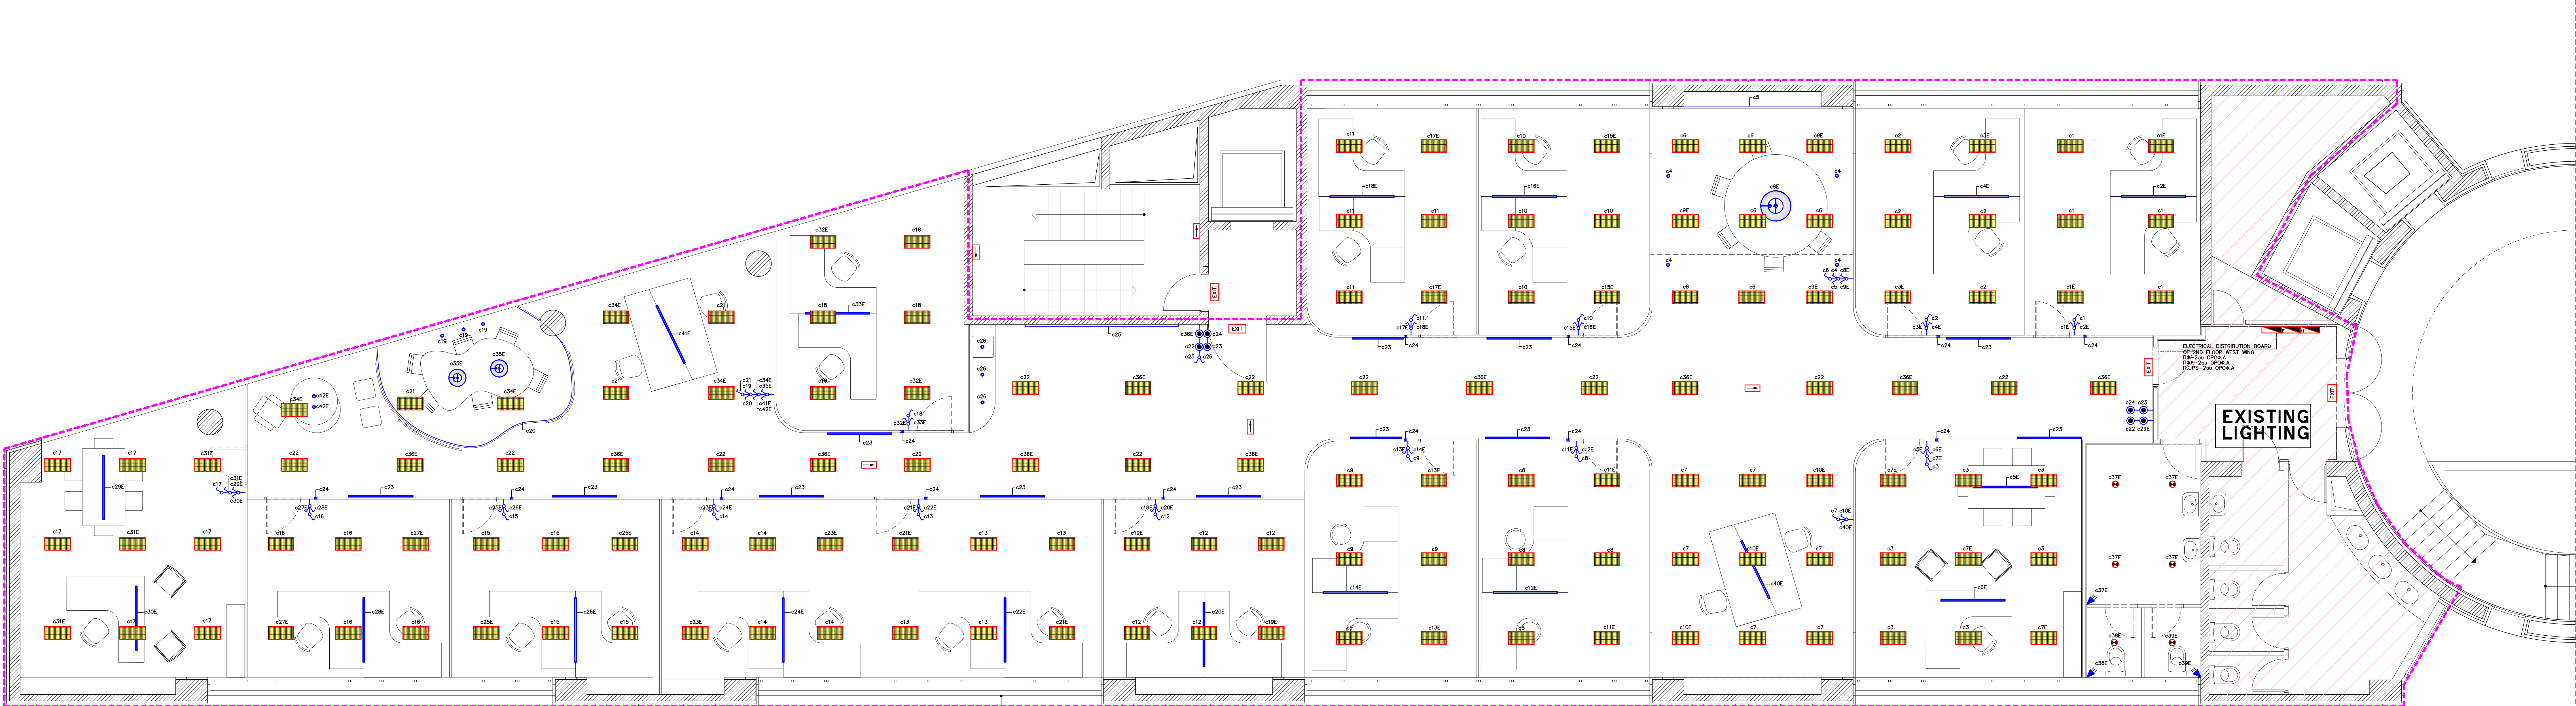

AREA SUPPLIED BY
ELECTRICAL DISTRIBUTION BOARDS
18-24W OP08A
110V-240V OP08A

CLIENT: 	
PROJECT: RENOVATION OFFICES	
LOCATION: VASILISSIS SOFIAS 1, MAROUSI ATHENS	
DRAWING: ELECTRICAL-LIGHTING SECOND FLOOR PLAN	
SCALE: 1:50	DRAWING NUMBER: H-08a
REVISION: α:05.02.14	DESIGN PHASE: DETAILED DESIGN
8, KIFISSIAS AVE, ATHENS 115 26 mail@kamarinos.com T. 210 6470910 F. 210 6470911	
MANAGER:	A.P.K. DATE: 23.12.13
ENGINEER:	E.P.T. REFERENCE: 158ENI
DESIGNER:	A.C.F. FILE NAME: 158H08a.dwg